ADDL	ADDITIONAL	MANUF OR MFR	MANUFACTURER
ALT	ALTERNATE	MATL	MATERIAL
AFF	ABOVE FINISH FLOOR	MAX	MAXIMUM
ASTM	AMERICAN SOCIETY FOR TESTING		MECHANICAL
	AND MATERIALS	MEMB MEP	MEMBRANE MECHANICAL EQUIPMENT PAD
AWS	AMERICAN WELDING SOCIETY	MID	MIDDLE
AB	ANCHOR BOLT	MID-PT	MID-POINT
& OR \$ APPROX	AND APPROXIMATELY	MIN	MINIMUM
ARCH	ARCHITECT OR ARCHITECTURAL	MR	MOISTURE RESISTANT
@	AT AT		
		NFPA	NATIONAL FOREST PRODUCTS
BAL	BALANCE		ASSOCIATION
BETW	BETWEEN	NOM	NOMINAL
BM	BEAM	NWC	NORMAL WEIGHT CONCRETE
BRG	BEARING	N	NORTH
BLK B OR BOT	BLOCK BOTTOM	NIC	NOT IN CONTRACT
BEW	BOTTOM EACH WAY	NTS	NOT TO SCALE
BRKT	BRACKET	NO OR #	NUMBER
BLDG	BUILDING	OC	ON CENTER
		OPNG	OPENING
CIP	CAST-IN-PLACE	OPP	OPPOSITE
CTRD	CENTERED	OD	OUTSIDE DIAMETER
	CENTERLINE	OF	OUTSIDE FACE
CLR	CLEAR	P.T.	
COL	COLUMN	PT	PRESSURE TREATED POINT
CONC	CONCRETE	PTD	PAINTED
CMU	CONCRETE MASONRY UNIT	PTB	POST-TENSIONED BAR
CONST	CONSTRUCTION	PSF	POUNDS PER SQUARE FOOT
CONSTJT OR CONT	CONSTRUCTION JOINT	PSI	POUNDS PER SQUARE INCH
CJ	CONTINUOUS CONTROL JOINT	PVC	POLYVINYL CHLORIDE
00	OOMITTOL OOMIT	P/C	PRECAST CONCRETE
DET	DETAIL	R	RADIUS
DIA OR Ø	DIAMETER	REF	REFERENCE
DIM	DIMENSION	REINF	REINFORCE, REINFORCING
DN	DOWN		OR REINFORCEMENT
DWG	DRAWING	REQD	REQUIRED
		RD	ROOF DRAIN
EA	EACH		
ELECT	ELECTRICAL	SCH OR SCHED	SEALANT
EL OR	ELEVATION	SECT OR SCHED	SCHEDULE SECTION
ELEV	ELEVATOR	SH	SHEET
EMBED	EMBEDMENT	SIM	SIMILAR
EQ	EQUAL	SOG	SLAB ON GRADE
EQUIP	EQUIPMENT	S	SOUTH
EXIST	EXISTING	SPECS	SPECIFICATIONS
EXP BOLT	EXPANSION BOLT EXPANSION JOINT	SPKR	SPRINKLER
EXT	EXTERIOR	SQ	SQUARE
		STN STL	STAINLESS STEEL
FF	FINISH FACE	STD	STANDARD
FT	FEET OR FOOT	STL	STEEL
FIN	FINISH	ST STL	STAINLESS STEEL
FIN FL	FINISHED FLOOR	STRUCT	STRUCTURAL
FPRF	FIREPROOF	SYM	SYMMETRICAL
FL	FLOOR	TEMP	TEMPERATURE OR
FD FTG	FLOOR DRAIN FOOTING		TEMPORARY
FDN	FOUNDATION	THK	THICK OR THICKNESS
GA	GAGE OR GAUGE	X	TIMES OR BY
GALV	GALVANIZED	TO	TOP OF
GWB or GYP	GYPSUM WALL BOARD	T & B	TOP AND BOTTOM
HGT	HEIGHT	TOC	TOP OF CURB or CONCRETE
H OR HORIZ	HORIZONTAL	TOS TOW	TOP OF STEEL TOP OF WALL
IN	INCH	TYP	TYPICAL
INFO	INFORMATION		
INCL	INCLUDING OR INCLUSIVE	UNO	UNLESS NOTED OTHERWISE
ID	INSIDE DIAMETER	V OR VERT	VERTICAL
IF INSUL	INSIDE FACE INSULATION	VIF	VERIFY IN FIELD
INSUL	INTERIOR	W	WEST
IINI		\ A (\) A (\) A	WESTERN WAS DESCRIPTED
INV	INVERT	WWPA	WESTERN WOOD PRODUCTS
			ASSOCIATION
INV JT	INVERT JOINT	W/	ASSOCIATION WITH
INV	INVERT		ASSOCIATION

SPRINGFIELD STREET RESIDENCES

EXISTING WALL TO BE REMOVED

EXISTING DOOR TO BE REMOVED

COMBO SMOKE/CO2 DETECTOR

(PHOTOELECTRIC)

KIDDE KN-COPE-IC

EXISTING WALL

PROPOSED WALL

EXISTING DOOR

PROPOSED DOOR

SYMBOL LEGEND

210 W. Springfield St., Boston, MA 02118

CODE ANALYSIS:

1. APPLICABLE CODES: **BUILDING CODE:** IBC 2015 (780 CMR) **IEBC 2015 IECC 2018** IFC 2015 (527 CMR) **8TH EDITION AMENDMENTS**

2. ZONING DISTRICT - SOUTH END NEIGHBORHOOD **ZONING SUBDISTRICT - MFR**

DIMENSIONAL REQUIREMENTS:

	REQ'D	PROPOSED
FRONT:	CONFORMITY	NO CHANGE
SIDE:	0'	NO CHANGE
REAR:	20'	NO CHANGE
HEIGHT:	70'	NO CHANGE
FΔR· 2.0		

LOT SIZE: 1,740SF ALLOWED: 3,480GSF **EXISTING: 3,780GSF** PROPOSED: 4,363GSF **BASEMENT: 730GSF GARDEN LEVEL: 730GSF** FIRST FLOOR: **743GSF SECOND FLOOR: 725GSF** THIRD FLOOR: **725GSF FOURTH FLOOR:** TOTAL: 4,363GSF

3. CHAPTER 3 - USE GROUP CLASSIFICATION: **SECTION 310.0 - RESIDENTIAL R2**

4. CHAPTER 6 - CONSTRUCTION CLASSIFICATION **TABLE 602 - UNIT SEPERATION - 1HR SECTION 602.5 - TYPE 5A CONSTRUCTION**

5. CHAPTER 10 - MEANS OF EGRESS: TABLE 1006.3.2(1) - 2ND MEANS OF EGRESS REQUIRED AT 4TH FLOOR (EXISTING TO REMAIN) SECTION 1030 - EMERGENCY ESCAPE & RESCUE

> **BEDROOM EGRESS:** 1 WINDOW MINIMUM REQUIREMENTS 5.7SF OPERABLE CLEAR AREA, 44" MAX SILL HGT

PERFORMANCE SPECIFICATIONS:

1.EXTERIOR WALLS: **EXISTING MASONRY** R21 MIN INSULATION VALUE (CAVITY) BASEMENT: R10 CONTINUOUS INSULATION OR R13 CAVITY INSULATION 2. WINDOWS: DOUBLE PANE LOW E MIN. U-FACTOR: .32 REQUIREMENTS FOR 1 WDW MIN PER BEDROOM: 5.7SF OPERABLE CLEAR AREA, 44" MAX SILL HGT 3. EXTERIOR DOORS: DOUBLE PANE LOW E MIN. U-FACTOR: .33 4. CEILING/ROOF **R49 MIN INSULATION VALUE** 5. FOUNDATION 10" MIN 2,500PSI MIN 6. STAIRS: COMMON: 7 1/2" MAX RISER

> 11" MIN TREAD INSIDE DWELLING: 8 1/4" MAX RISER

BALUSTERS: 4" MAX CLEAR WIDTH

HANDRAILS:

10" MIN TREAD

Room name 101 **ROOM TAG** SHEET# **ELEVATION TAG** 1HR RATED PARTITION (UL DESIGN U309) **HEAT DETECTOR - KIDDE HD135F** SA/CO2 COMBO SMOKE/CO2 DETECTOR -**KIDDE 112010SCO**

TITLE SHEET A100 DEMO PLANS A101 DEMO PLANS S100 FRAMING PLANS

DRAWING LIST

S101 FRAMING PLANS A102 FLOOR PLANS - BSMT - 2ND FLOORS A103 FLOOR PLANS - 3RD - ROOF PLANS EXISTING PLANS - BSMT - 2ND FLOORS EXISTING PLANS - 3RD & 4TH A200 EXTERIOR ELEVATIONS EXISTING ELEVATIONS

SHEET NAME

GENERAL NOTES:

1. WORK SHALL COMPLY WITH FEDERAL, STATE AND LOCAL BUILDING CODES AND REGULATIONS. UNLESS OTHERWISE AGREED UPON, THE CONTRACTOR IS RESPONSIBLE FOR SECURING ALL BUILDING PERMITS AS REQUIRED TO PERFORM HIS OR HER WORK AND WILL RETAIN AND PAY FOR ALL REQUIRED INSPECTIONS FOR THE DURATION OF CONSTRUCTION.

2. CONTRACTOR SHALL VERIFY ALL EXISTING CEILINGS AND EGRESS STAIRS ARE 1HR FIRE RATED. SINGLE LAYER OF PLASTER OR 5/8" GWB EACH SIDE OF INTERIOR PARTITION (UL DESIGN# L305), SINGLE 5/8" AT CEILINGS (UL DESIGN# L512). ALL REPLACEMENT PATCHING OR REPAIRING IS THE RESPONSIBILITY OF CONTRACTOR. CONTACT ARCHITECT IF RATING IS BELIEVED TO BE INHERENT IN EXISTING ASSEMBLY.

3. CONTRACTOR SHALL ENGAGE A LICENSED ELECTRICIAN FOR ALL ELECTRICAL **WORK AND IN COMPLIANCE WITH NFPA 70.**

4. CONTRACTOR RESPONSIBLE FOR ALL PREPARATION WORK REQUIRED BY MANUFACTURER'S SPECIFICATIONS.

5. CONTRACTOR SHALL PROVIDE PRODUCT SUBMITTAL FOR SMOKE ALARM **FIXTURES FOR APPORVAL**

6. CONFLICTS BETWEEN SITE CONDITIONS AND DRAWINGS SHALL BE BROUGHT TO THE IMMEDIATE ATTENTION OF THE ARCHITECT OR THE APPROPRIATE **CONSULTING ENGINEERS.**


7. CONFIRM DIMENSIONS WITH THE ARCHITECT OR APPROPRIATE CONSULTING ENGINEER.

8. CONTRACTOR TO NOTIFY ARCHITECT, AFTER LAYOUT AND PRIOR TO FRAMING, OF ANY DISCREPANCY, OMISSION, OR UNANTICIPATED FIELD CONDITIONS ALTER THE DESIGN INTENT.

9. CONTRACTOR TO NOTIFY ARCHITECT, AFTER LAYOUT AND PRIOR TO FRAMING, IF DIMENSIONS INDICATED WITH "+/-" VARIES MORE THAN 3" FROM ACTUAL FIELD MEASURMENTS.


10. CONTRACTOR RESPONSIBLE FOR ALL PREPARATION WORK REQUIRED BY MANUFACTURER'S SPECIFICATIONS.

11. DAMAGED TO EXISTING OR NEW CONSTRUCTION CAUSED BY THE CONTRACTOR HIS OR HER SUB-CONTRACTORS OR CREW IS THE RESPONSIBILITY OF THE CONTRACTOR.

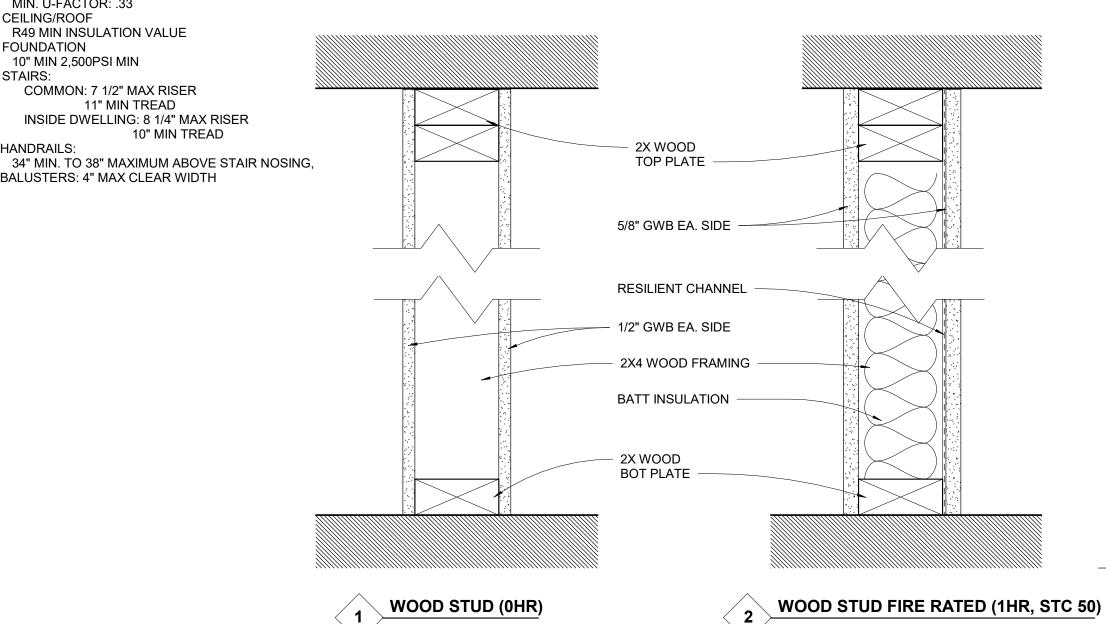

PARTITION TYPES

✓ 3" = 1'-0"

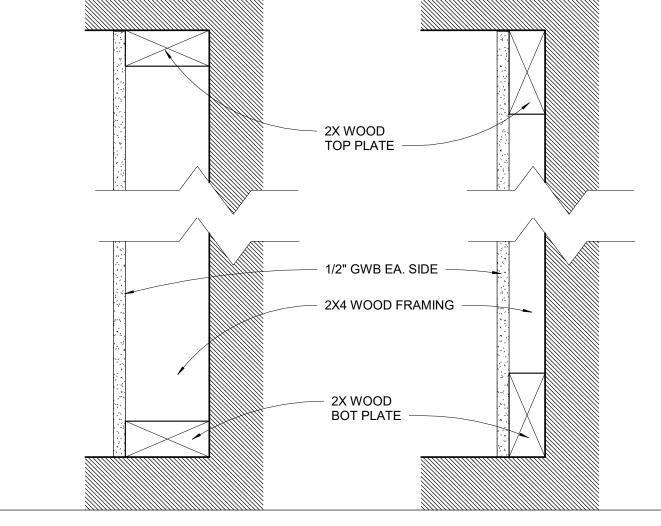

4" WOOD STUD FURRED (0HR)



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PROJECT: Springfield Residences

210 W. Springfield St Boston, MA 02118

CLIENT:

River Front Realty

275 Main St Boston, MA 02129

PROJECT TEAM:

REVISIONS:

DRAWING TITLE:


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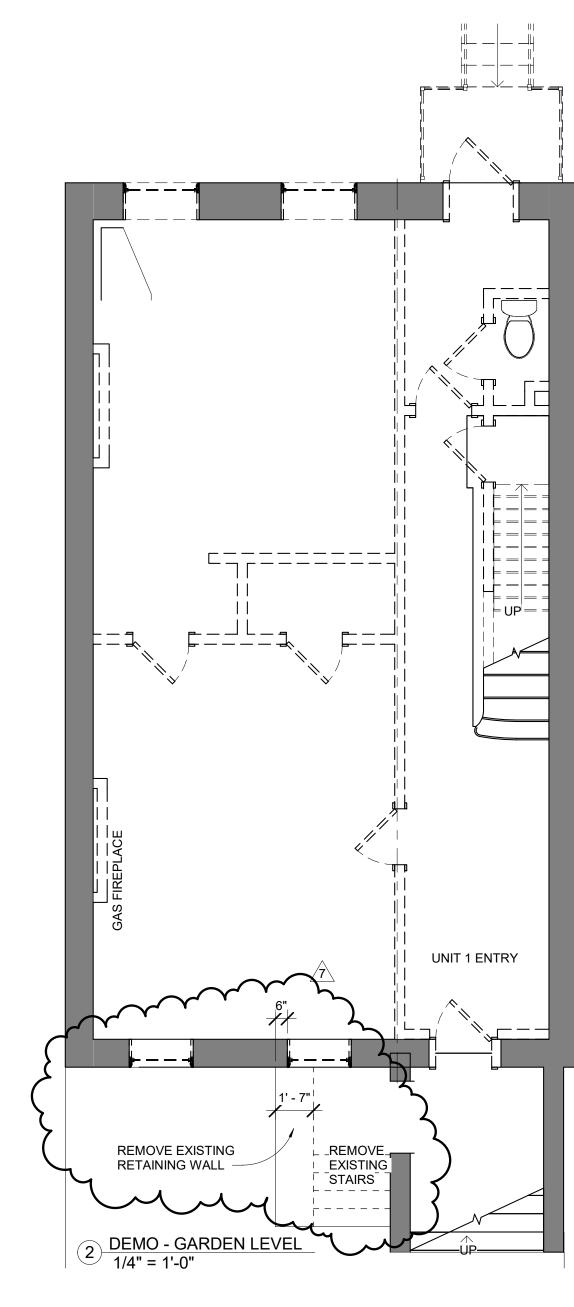
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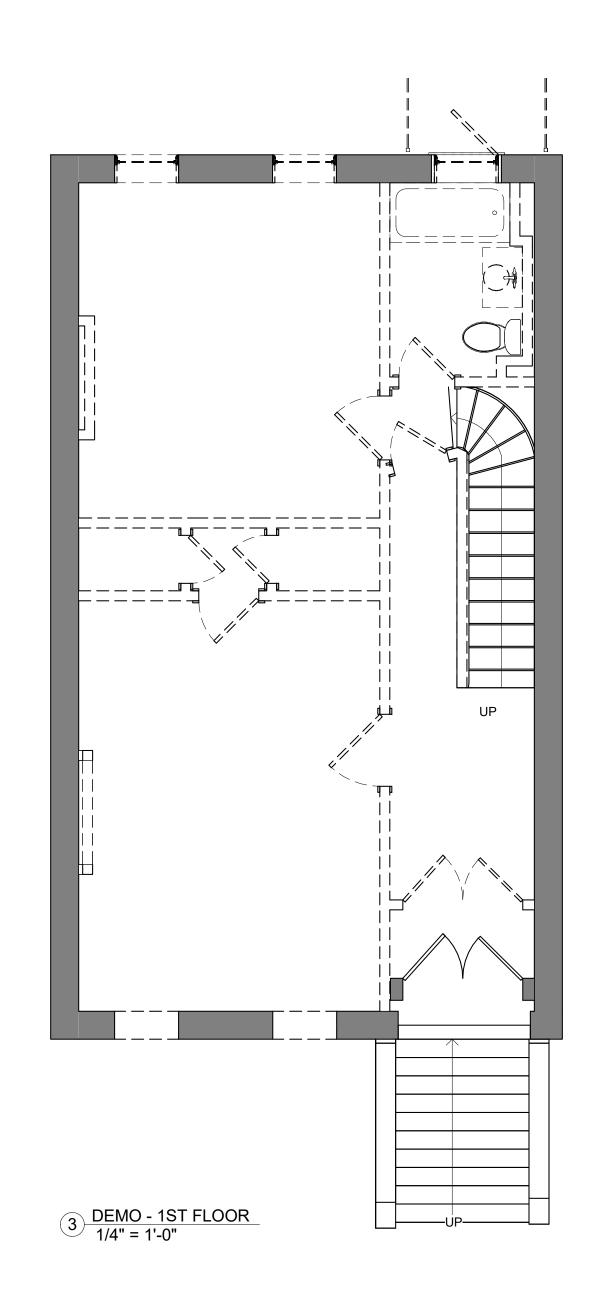



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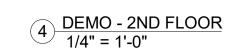
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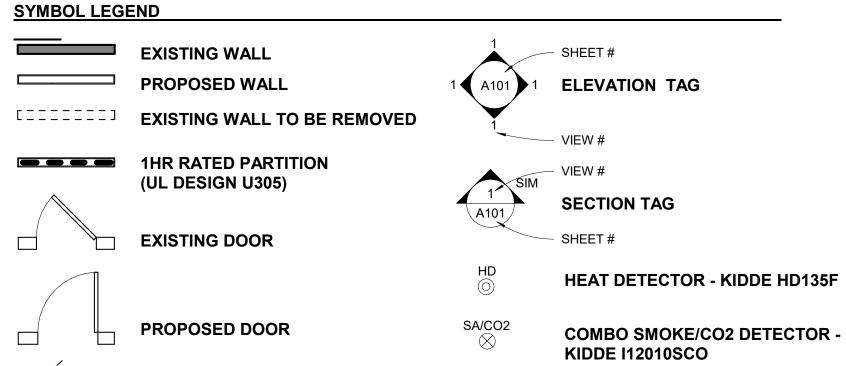








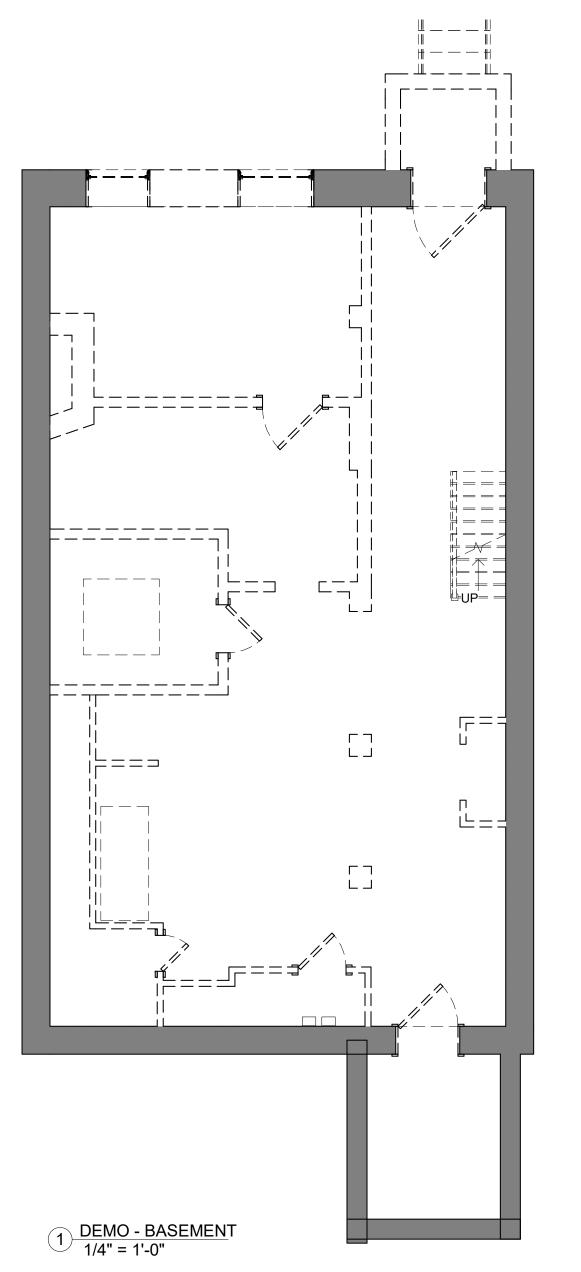

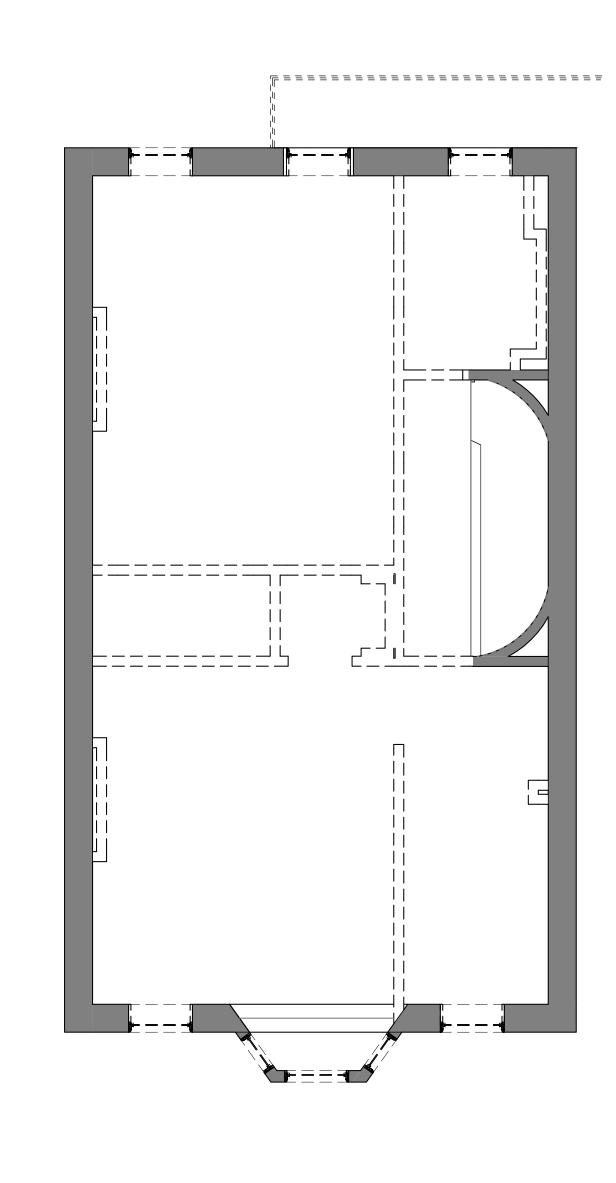

EXISTING DOOR TO BE REMOVED

COMBO SMOKE/CO2 DETECTOR

(PHOTOELECTRIC) KIDDE KN-COPE-IC

FINISH NOTES:

1. ALL EXISTING CEILING, FLOOR AND WALL FINISHES TO BE REMOVED AND EXISTING FRAMING EXPOSED.

ALL EXISITNG INTERIOR DOORS TO BE REMOVED AND REPLACED IN KIND.
 ALL EXISTING PLUMBING AND PLUMBING FIXTURES TO BE REMOVED AND REPLACED WITH UPDATED PLUMBING AND FIXTURES.

4. ALL EXISTING ELECTRICAL WIRING AND FIXTURES TO BE REMOVED AND REPLACED WITH UPDATED WIRING AND FIXTURES.

ARCHITECT S47

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PROJECT:
Springfield
Residences

210 W. Springfield St Boston, MA 02118

CLIENT:

River Front Realty

275 Main St Boston, MA 02129


PROJECT TEAM:

REVISIONS:
7 HISTORICAL

DRAWING TITLE:

DEMO PLANS

STAI

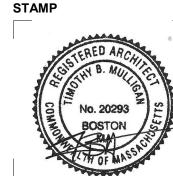

May 13, 2022
DATE OF ISSUE
PERMITTING
DOCUMENT PHASE

DOCUMENT PHASE

1/4" = 1'-0"

SCALE

DRAWING NUMBER:

|-===== _____

1 DEMO - 4TH FLOOR 1/4" = 1'-0"

EXISTING WALL - SHEET# PROPOSED WALL 1 A101 1 ELEVATION TAG [EXISTING WALL TO BE REMOVED 1HR RATED PARTITION (UL DESIGN U305) **SECTION TAG EXISTING DOOR** HEAT DETECTOR - KIDDE HD135F PROPOSED DOOR COMBO SMOKE/CO2 DETECTOR - KIDDE I12010SCO

EXISTING DOOR TO BE REMOVED

SYMBOL LEGEND

COMBO SMOKE/CO2 DETECTOR (PHOTOELECTRIC)
KIDDE KN-COPE-IC

FINISH NOTES:

1. ALL EXISTING CEILING, FLOOR AND WALL FINISHES TO BE REMOVED AND EXISTING FRAMING EXPOSED.

2. ALL EXISITNG INTERIOR DOORS TO BE REMOVED AND REPLACED IN KIND. 3. ALL EXISTING PLUMBING AND PLUMBING FIXTURES TO BE REMOVED AND REPLACED WITH UPDATED PLUMBING AND FIXTURES.

4. ALL EXISTING ELECTRICAL WIRING AND FIXTURES TO BE REMOVED AND REPLACED WITH UPDATED WIRING AND FIXTURES.



ARCHITECT

517 boston post rd suite #30

sudbury, ma 01776 p: 508.500.4730 www.s47a.com

PROJECT: Springfield Residences

210 W. Springfield St Boston, MA 02118

CLIENT:

River Front Realty

275 Main St Boston, MA 02129

PROJECT TEAM:

REVISIONS:

DEMO PLANS


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STAMP





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DRAWING NUMBER:



6.22.22 4 DECKS/SLIDER 1.11.23

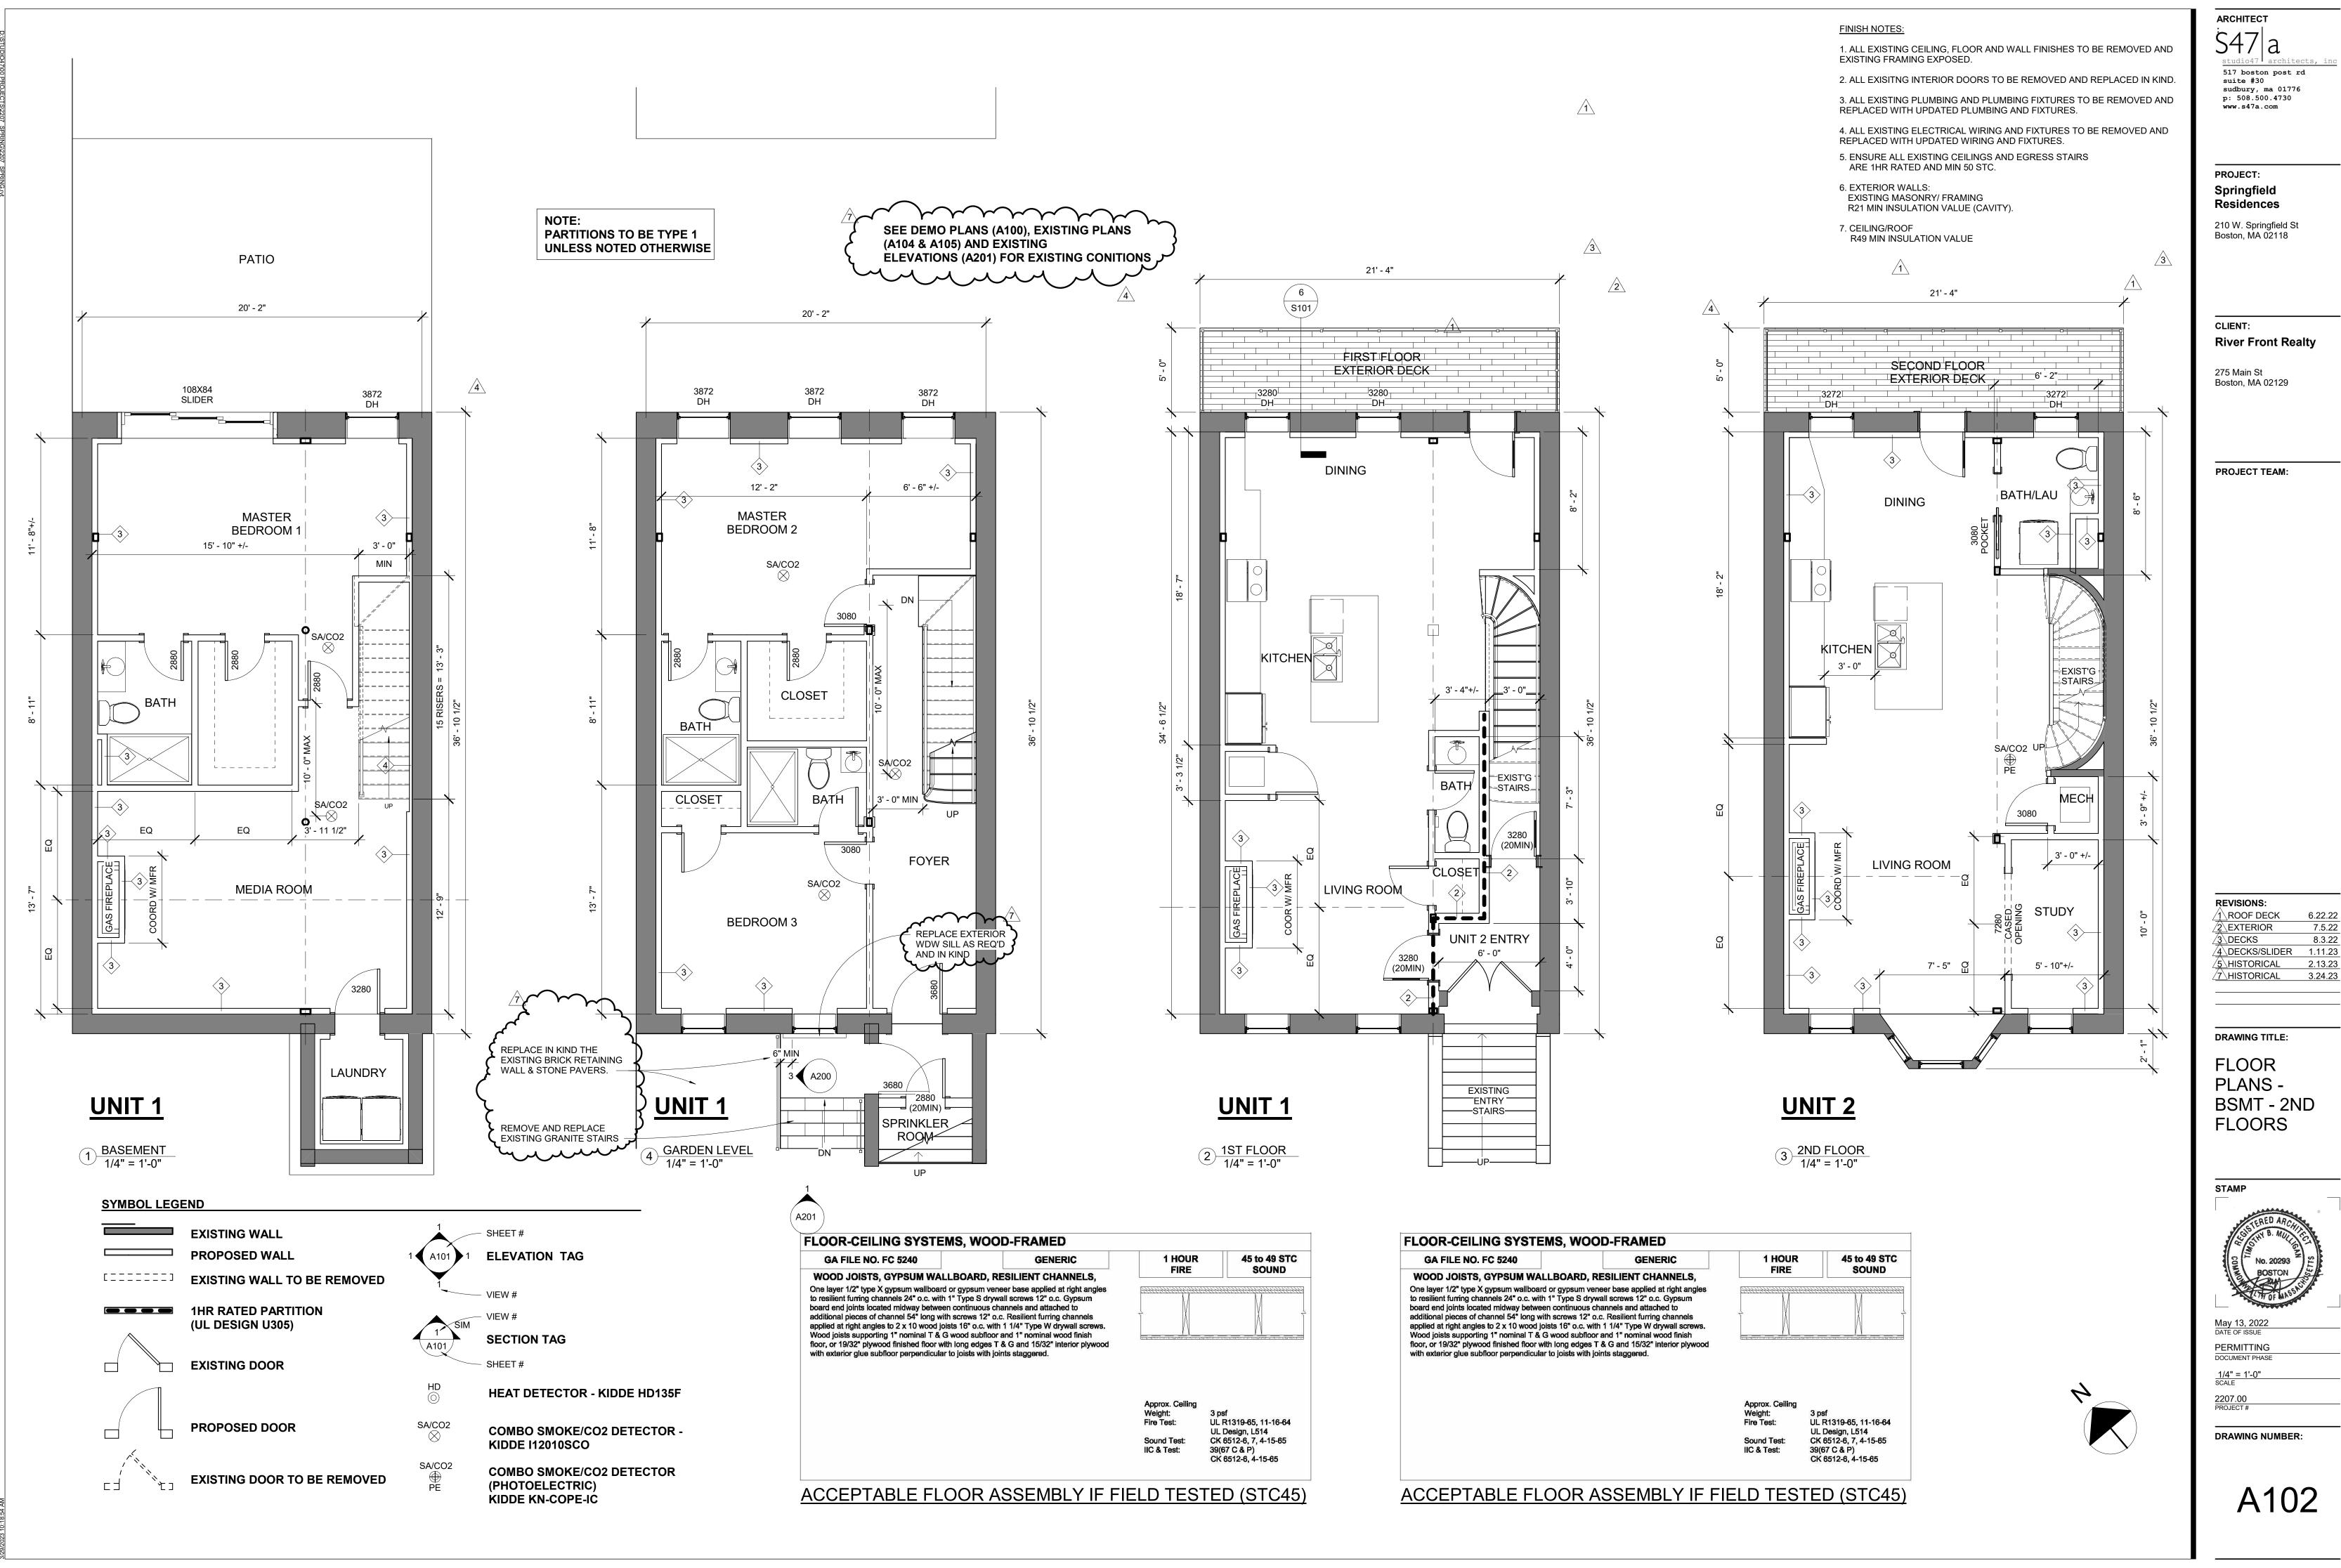

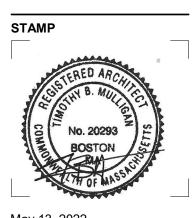

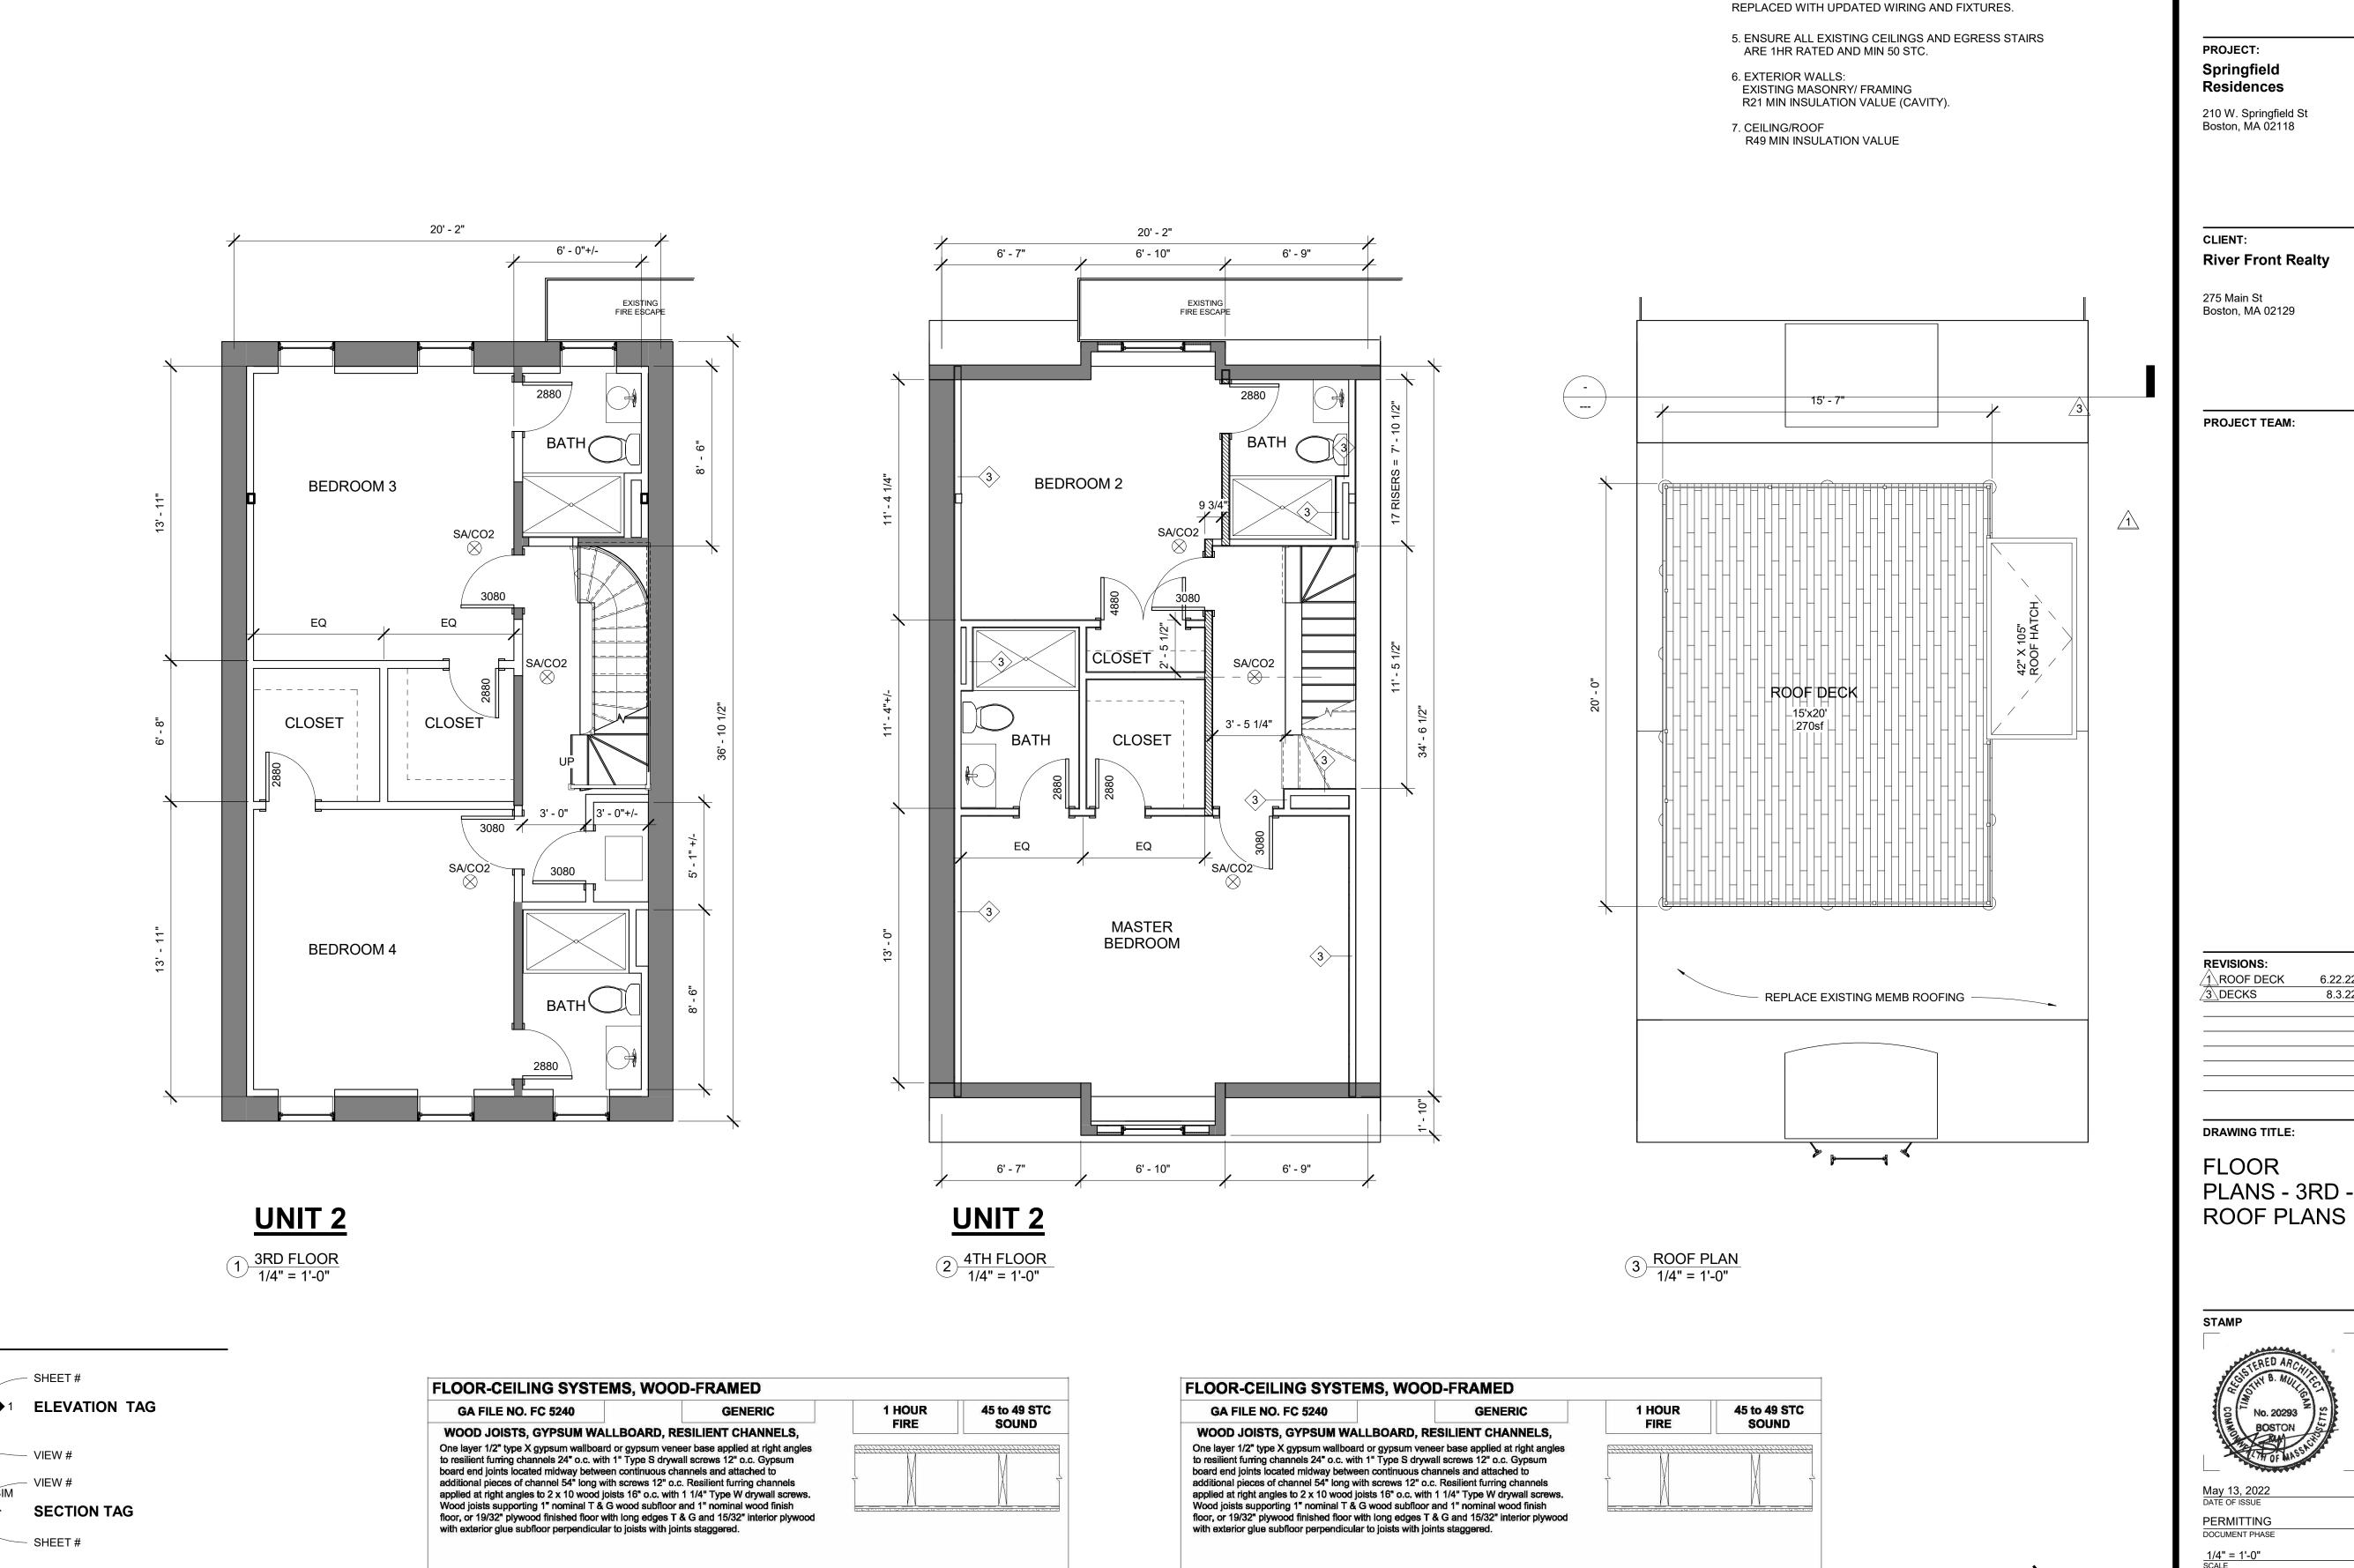3 psf UL R1319-65, 11-16-64

UL Design, L514 CK 6512-6, 7, 4-15-65

CK 6512-6, 4-15-65

39(67 C & P)

ACCEPTABLE FLOOR ASSEMBLY IF FIELD TESTED (STC45)

SYMBOL LEGEND

EXISTING WALL

PROPOSED WALL

(UL DESIGN U305)

EXISTING DOOR

PROPOSED DOOR

1HR RATED PARTITION

EXISTING WALL TO BE REMOVED

EXISTING DOOR TO BE REMOVED

HEAT DETECTOR - KIDDE HD135F

COMBO SMOKE/CO2 DETECTOR

COMBO SMOKE/CO2 DETECTOR

KIDDE I12010SCO

(PHOTOELECTRIC)

KIDDE KN-COPE-IC

SA/CO2

FINISH NOTES:

UL R1319-65, 11-16-64

UL Design, L514 CK 6512-6, 7, 4-15-65

CK 6512-6, 4-15-65

39(67 C & P)

Sound Test:

IIC & Test:

ACCEPTABLE FLOOR ASSEMBLY IF FIELD TESTED (STC45)

EXISTING FRAMING EXPOSED.

1. ALL EXISTING CEILING, FLOOR AND WALL FINISHES TO BE REMOVED AND

2. ALL EXISITNG INTERIOR DOORS TO BE REMOVED AND REPLACED IN KIND.

3. ALL EXISTING PLUMBING AND PLUMBING FIXTURES TO BE REMOVED AND

4. ALL EXISTING ELECTRICAL WIRING AND FIXTURES TO BE REMOVED AND

REPLACED WITH UPDATED PLUMBING AND FIXTURES.

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sudbury, ma 01776

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suite #30

A103

DRAWING NUMBER:

6.22.22

8.3.22

CODE ANALYSIS:

1. APPLICABLE CODES: **BUILDING CODE** IBC 2015 (780 CMR) **IEBC 2015 IECC 2018**

ZONING SUBDISTRICT - MFR

IFC 2015 (527 CMR) 8TH EDITION AMENDMENTS


DIMENSIONAL REQUIREMENTS:

2. ZONING DISTRICT - SOUTH END NEIGHBORHOOD


	REQ'D	PROPOSE
FRONT:	CONFORMITY	NO CHANG
SIDE:	0'	NO CHANG
REAR:	20'	NO CHANG
HEIGHT:	70'	NO CHANG

FAR: 2.0 LOT SIZE: 1,740SF ALLOWED: 3,480GSF EXISTING: 3,780GSF PROPOSED: NO CHANGE

- 3. CHAPTER 3 USE GROUP CLASSIFICATION: **SECTION 310.0 - RESIDENTIAL R2**
- 4. CHAPTER 6 CONSTRUCTION CLASSIFICATION **TABLE 602 - UNIT SEPERATION - 1HR SECTION 602.5 - TYPE 5A CONSTRUCTION**
- 5. CHAPTER 10 MEANS OF EGRESS: TABLE 1006.3.2(1) - 2ND MEANS OF EGRESS REQUIRED AT **4TH FLOOR (EXISTING TO REMAIN)**
 - **SECTION 1030 EMERGENCY ESCAPE & RESCUE BEDROOM EGRESS:** 1 WINDOW MINIMUM REQUIREMENTS 5.7SF OPERABLE CLEAR AREA, 44" MAX SILL HGT

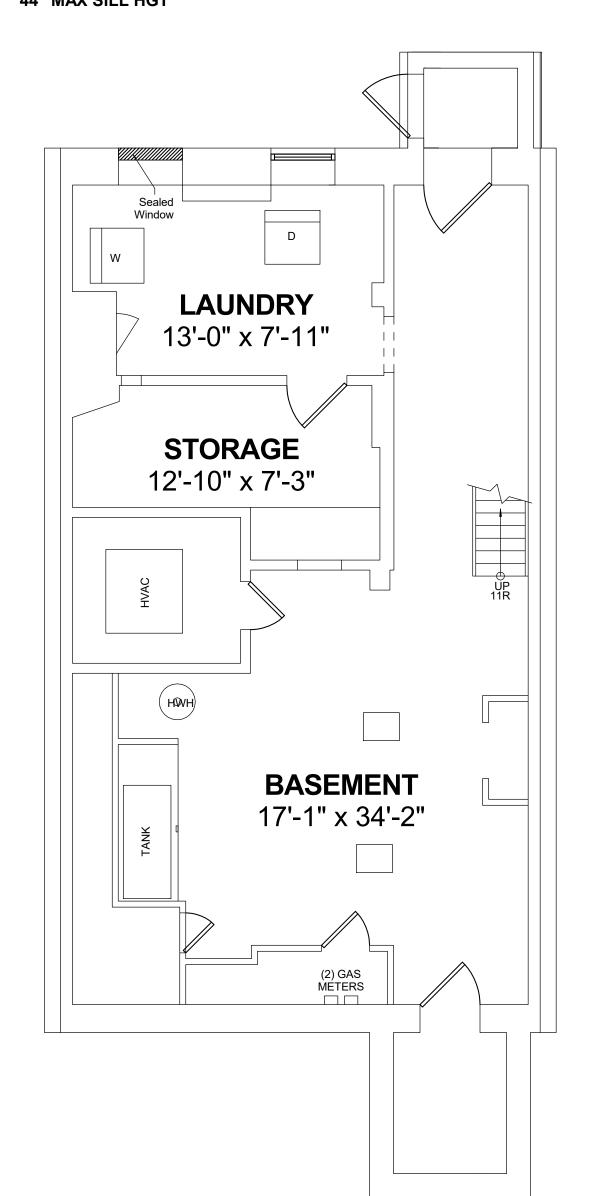



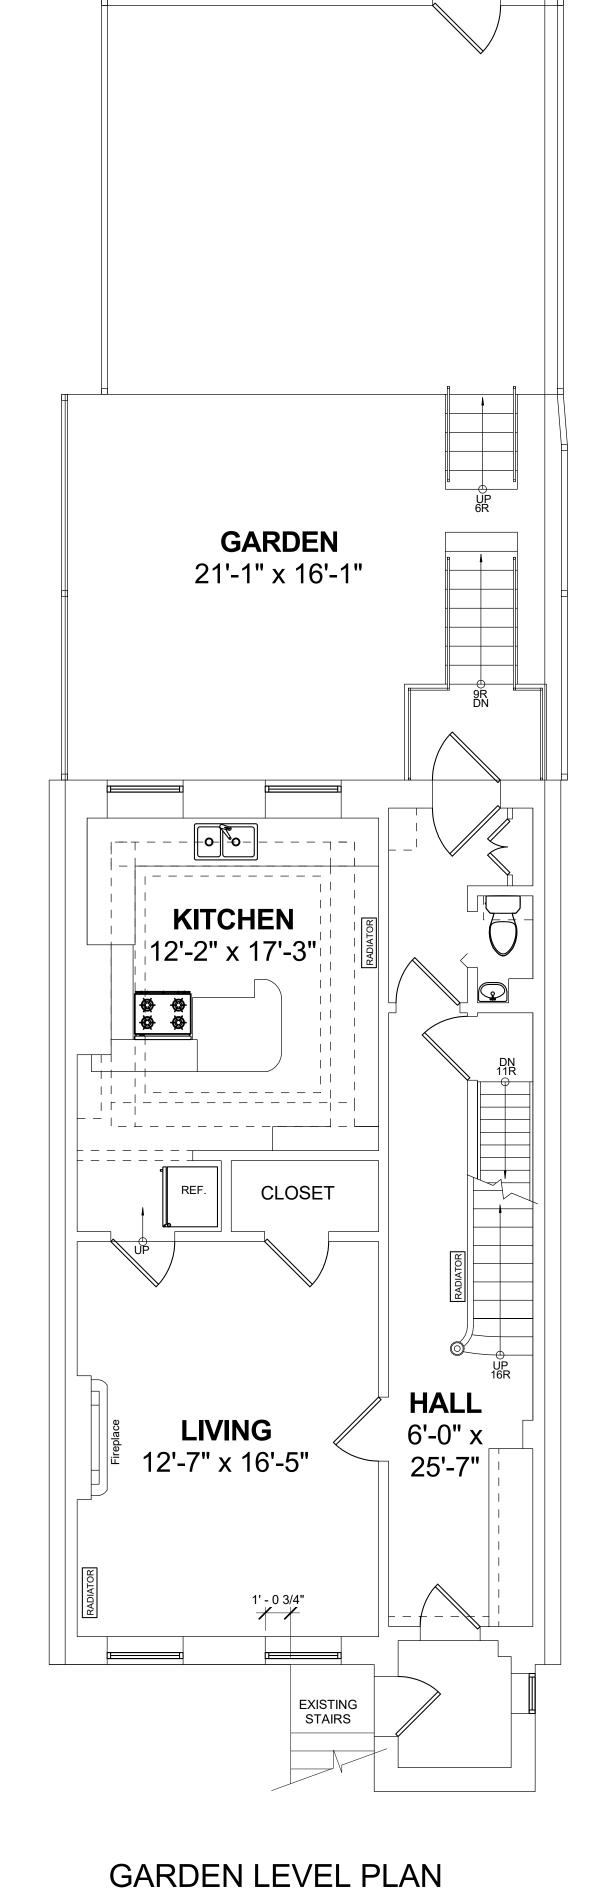

FLOOR-CEILING SYSTEMS, WOOD-FRAMED

GA FILE NO. FC 5240		GENERIC	1 HOUR	
WOOD JOISTS, GYPSUM WA	LLBOARD, RI	ESILIENT CHANNELS.	FIRE	SOUND
One layer 1/2" type X gypsum wallboar to resilient furring channels 24" o.c. wit board end joints located midway betwee additional pieces of channel 54" long wapplied at right angles to 2 x 10 wood j Wood joists supporting 1" nominal T & floor, or 19/32" plywood finished floor with exterior glue subfloor perpendicular	th 1" Type S drywa een continuous cha vith screws 12" o.c joists 16" o.c. with G wood subfloor with long edges T	all screws 12" o.c. Gypsum annels and attached to c. Resilient furring channels 1 1/4" Type W drywall screws. and 1" nominal wood finish & G and 15/32" interior plywood		
			Approx. Ceiling Weight: Fire Test: Sound Test: IIC & Test:	3 psf UL R1319-65, 11-16-64 UL Design, L514 CK 6512-6, 7, 4-15-65 39(67 C & P)

ACCEPTABLE FLOOR ASSEMBLY IF FIELD TESTED (STC45)

ACCEPTABLE FLOOR ASSEMBLY IF FIELD TESTED (STC45)

FLOOR-CEILING SYSTEMS, WOOD-FRAMED

with exterior glue subfloor perpendicular to joists with joints staggered.

WOOD JOISTS, GYPSUM WALLBOARD, RESILIENT CHANNELS,

to resilient furring channels 24" o.c. with 1" Type S drywall screws 12" o.c. Gypsum board end joints located midway between continuous channels and attached to additional pieces of channel 54" long with screws 12" o.c. Resilient furring channels

One layer 1/2" type X gypsum wallboard or gypsum veneer base applied at right angles

applied at right angles to 2 x 10 wood joists 16" o.c. with 1 1/4" Type W drywall screws. Wood joists supporting 1" nominal T & G wood subfloor and 1" nominal wood finish

floor, or 19/32" plywood finished floor with long edges T & G and 15/32" interior plywood

GA FILE NO. FC 5240

5. ENSURE ALL EXISTING CEILINGS AND EGRESS STAIRS ARE 1HR RATED AND MIN 50 STC.

CK 6512-6, 4-15-65

6. EXTERIOR WALLS: EXISTING MASONRY/ FRAMING R21 MIN INSULATION VALUE (CAVITY).

R49 MIN INSULATION VALUE

BATH

5'-6" x

FOYER

6'-0" x 17'-8"

7. CEILING/ROOF

5. ALL EXISITNG DOORS TO BE REMOVED AND REPLACED IN KIND.

BEDROOM

12'-6" x 13'-11"

LIVING

12'-6" x 17'-1"

EXISTING PATIO

FIRST FLOOR PLAN

CLOSET

CLOSET

1. ALL EXISTING CEILING, FLOOR AND WALL FINISHES TO BE REMOVED AND

3. ALL EXISTING PLUMBING AND PLUMBING FIXTURES TO BE REMOVED AND

4. ALL EXISTING ELECTRICAL WIRING AND FIXTURES TO BE REMOVED AND

2. ALL EXISITNG DOORS AND WINDOWS TO BE REMOVED AND REPLACED IN KIND.

6. ALL EXISTING EXTERIOR MASONRY VENEER TO REMAIN AND REPAIRED AS REQUIRED.

REPLACED WITH UPDATED PLUMBING AND FIXTURES.

REPLACED WITH UPDATED WIRING AND FIXTURES.

FINISH NOTES:

EXISTING FRAMING EXPOSED.

BEDROOM 12'-5" x 16'-3" CLOSET **LIVING** 12'-3" x 16'-8"

SECOND FLOOR PLAN

FIRE ESCAPE BATH 6'-4" x 14'-1"

45 to 49 STC

SOUND

UL R1319-65, 11-16-64 UL Design, L514 CK 6512-6, 7, 4-15-65

CK 6512-6, 4-15-65

39(67 C & P)

1 HOUR

Approx. Ceiling

Sound Test:

IIC & Test:

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PROJECT: Springfield Residences

210 W. Springfield St Boston, MA 02118

CLIENT:

River Front Realty

275 Main St

Boston, MA 02129

PROJECT TEAM:

REVISIONS: 7 HISTORICAL 3.24.23

DRAWING TITLE:

EXISTING PLANS -BSMT - 2ND **FLOORS**

STAMP

PERMITTING

DRAWING NUMBER:

GA FILE NO. FC 5240	GENERIC	1 HOUR	45 to 49 STC
WOOD JOISTS, GYPSUM W	ALLBOARD, RESILIENT CHANNELS,	FIRE	SOUND
o resilient furring channels 24" o.c. voord end joints located midway bet additional pieces of channel 54" long applied at right angles to 2 x 10 woo Vood joists supporting 1" nominal T	pard or gypsum veneer base applied at right angles with 1" Type S drywall screws 12" o.c. Gypsum ween continuous channels and attached to with screws 12" o.c. Resilient furring channels d joists 16" o.c. with 1 1/4" Type W drywall screws. & G wood subfloor and 1" nominal wood finish r with long edges T & G and 15/32" interior plywood		
Tall Oxionol grad dubilour perpendic	ular to joists with joints staggered.		
van oxestor grae dubilosi perpendic	ular to joists with joints staggered.	Approx. Ceiling Weight: Fire Test:	3 psf UL R1319-65, 11-16-64 UL Design, L514

GA FILE NO. FC 5240	GENERIC	1 HOUR	45 to 49 S
WOOD JOISTS, GYPSUM WALLB	DARD, RESILIENT CHANNELS,	FIRE	SOUND
One layer 1/2" type X gypsum wallboard or g to resilient furing channels 24" o.c. with 1" T board end joints located midway between co additional pieces of channel 54" long with sc applied at right angles to 2 x 10 wood joists Wood joists supporting 1" nominal T & G wo floor, or 19/32" plywood finished floor with lo with exterior glue subfloor perpendicular to joint for the support of the supp	ype S drywall screws 12" o.c. Gypsum ntinuous channels and attached to news 12" o.c. Resilient furring channels 6" o.c. with 1 1/4" Type W drywall screws. od subfloor and 1" nominal wood finish ng edges T & G and 15/32" interior plywood		

ACCEPTABLE FLOOR ASSEMBLY IF FIELD TESTED (STC45)

ACCEPTABLE FLOOR ASSEMBLY IF FIELD TESTED (STC45)

FINISH NOTES:

ARE 1HR RATED AND MIN 50 STC. 1. ALL EXISTING CEILING, FLOOR AND WALL FINISHES TO BE REMOVED AND 6. EXTERIOR WALLS:

7. CEILING/ROOF

R49 MIN INSULATION VALUE

5. ENSURE ALL EXISTING CEILINGS AND EGRESS STAIRS


EXISTING FRAMING EXPOSED. EXISTING MASONRY/ FRAMING R21 MIN INSULATION VALUE (CAVITY). 2. ALL EXISITNG DOORS AND WINDOWS TO BE REMOVED AND REPLACED IN KIND.


3. ALL EXISTING PLUMBING AND PLUMBING FIXTURES TO BE REMOVED AND REPLACED WITH UPDATED PLUMBING AND FIXTURES.

4. ALL EXISTING ELECTRICAL WIRING AND FIXTURES TO BE REMOVED AND REPLACED WITH UPDATED WIRING AND FIXTURES.

5. ALL EXISITNG DOORS TO BE REMOVED AND REPLACED IN KIND.

6. ALL EXISTING EXTERIOR MASONRY VENEER TO REMAIN AND REPAIRED AS REQUIRED.

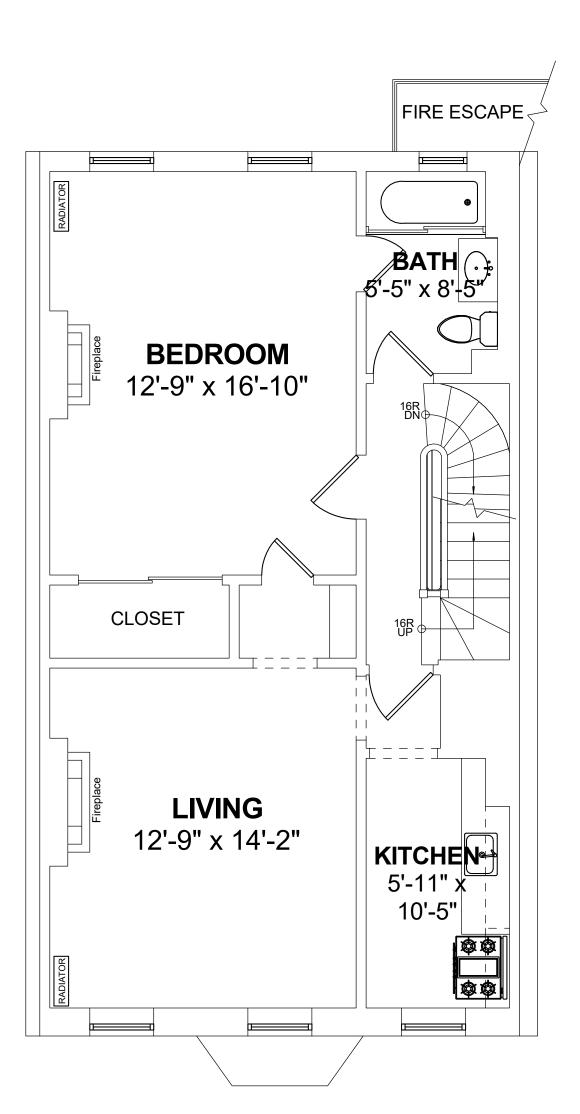

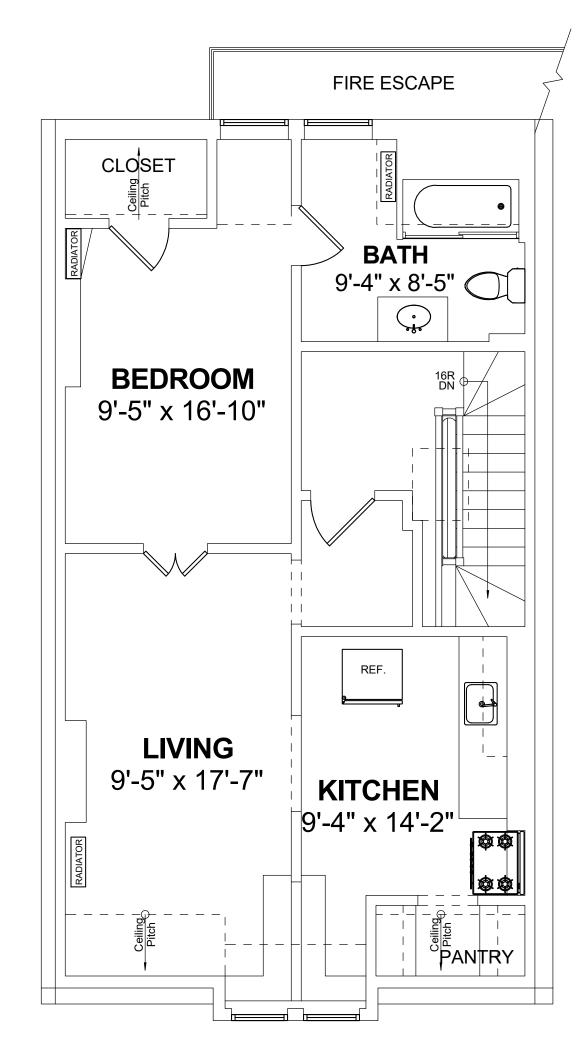

THIRD FLOOR PLAN

FOURTH FLOOR PLAN

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> PROJECT: Springfield Residences

210 W. Springfield St Boston, MA 02118

CLIENT:

River Front Realty

275 Main St Boston, MA 02129

PROJECT TEAM:

1 ROOF DECK 6.22.22

DRAWING TITLE:

REVISIONS:

EXISTING PLANS - 3RD & 4TH



PERMITTING DOCUMENT PHASE

DRAWING NUMBER:





ARCHITECT

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517 boston post rd
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sudbury, ma 01776

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PROJECT:
Springfield
Residences

210 W. Springfield St Boston, MA 02118

CLIENT:

River Front Realty

275 Main St Boston, MA 02129

PROJECT TEAM:

 REVISIONS:

 1 ROOF DECK
 6.22.22

 3 DECKS
 8.3.22

 4 DECKS/SLIDER
 1.11.23

 5 HISTORICAL
 2.13.23

 7 HISTORICAL
 3.24.23

DRAWING TITLE:

EXTERIOR ELEVATIONS

STAMP



DATE OF ISSUE

PERMITTING

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1/4" = 1'-0"

1/4" = 1'-0' SCALE 2207.00

DRAWING NUMBER:

4TH FLOOR 40' - 7" 3RD FLOOR 30' - 4" 2ND FLOOR 19' - 9" 1ST FLOOR 7' - 8" FIN GRADE 0" 1' - 0 3/4" - - - - -GARDEN LEVEL 1) EXISTING FRONT ELEVATION 1/4" = 1'-0" 2 EXISTING REAR ELEVATION 1/4" = 1'-0"

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REVISIONS:

2 EXTERIOR

DRAWING TITLE:

EXISTING ELEVATIONS

STAMP





May 13, 2022
DATE OF ISSUE
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PROJECT#

DRAWING NUMBER:



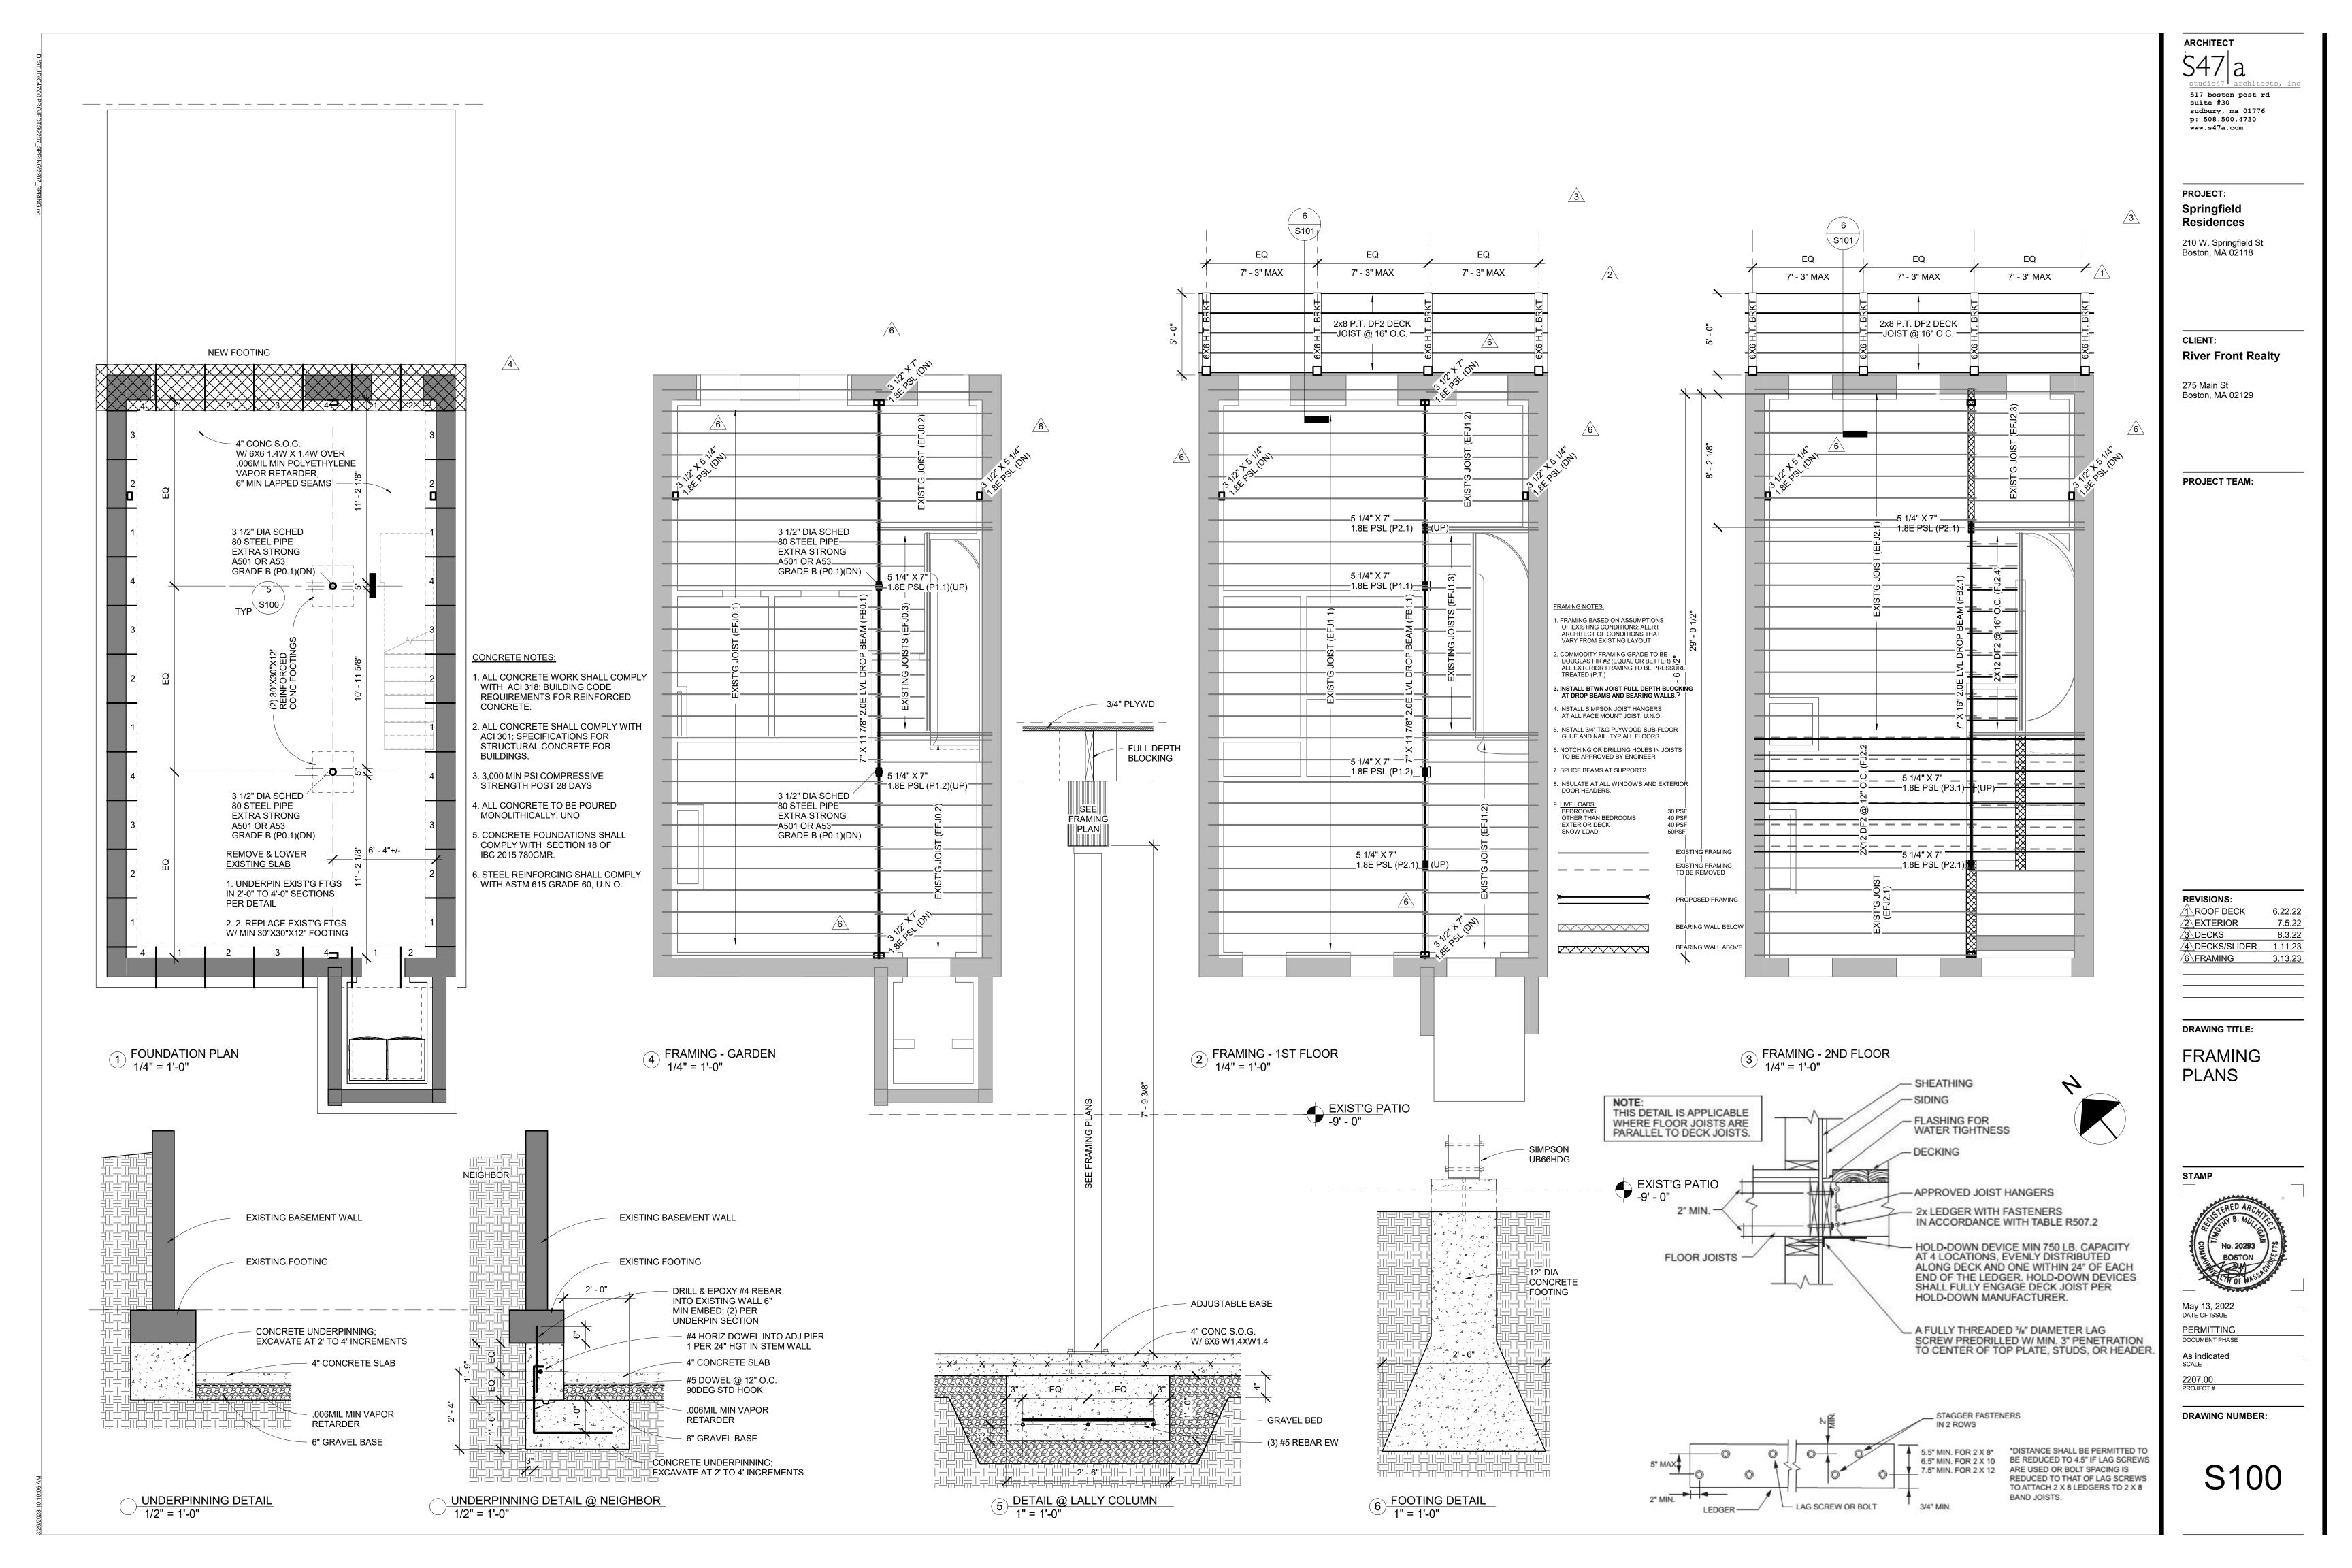

ARCHITECT
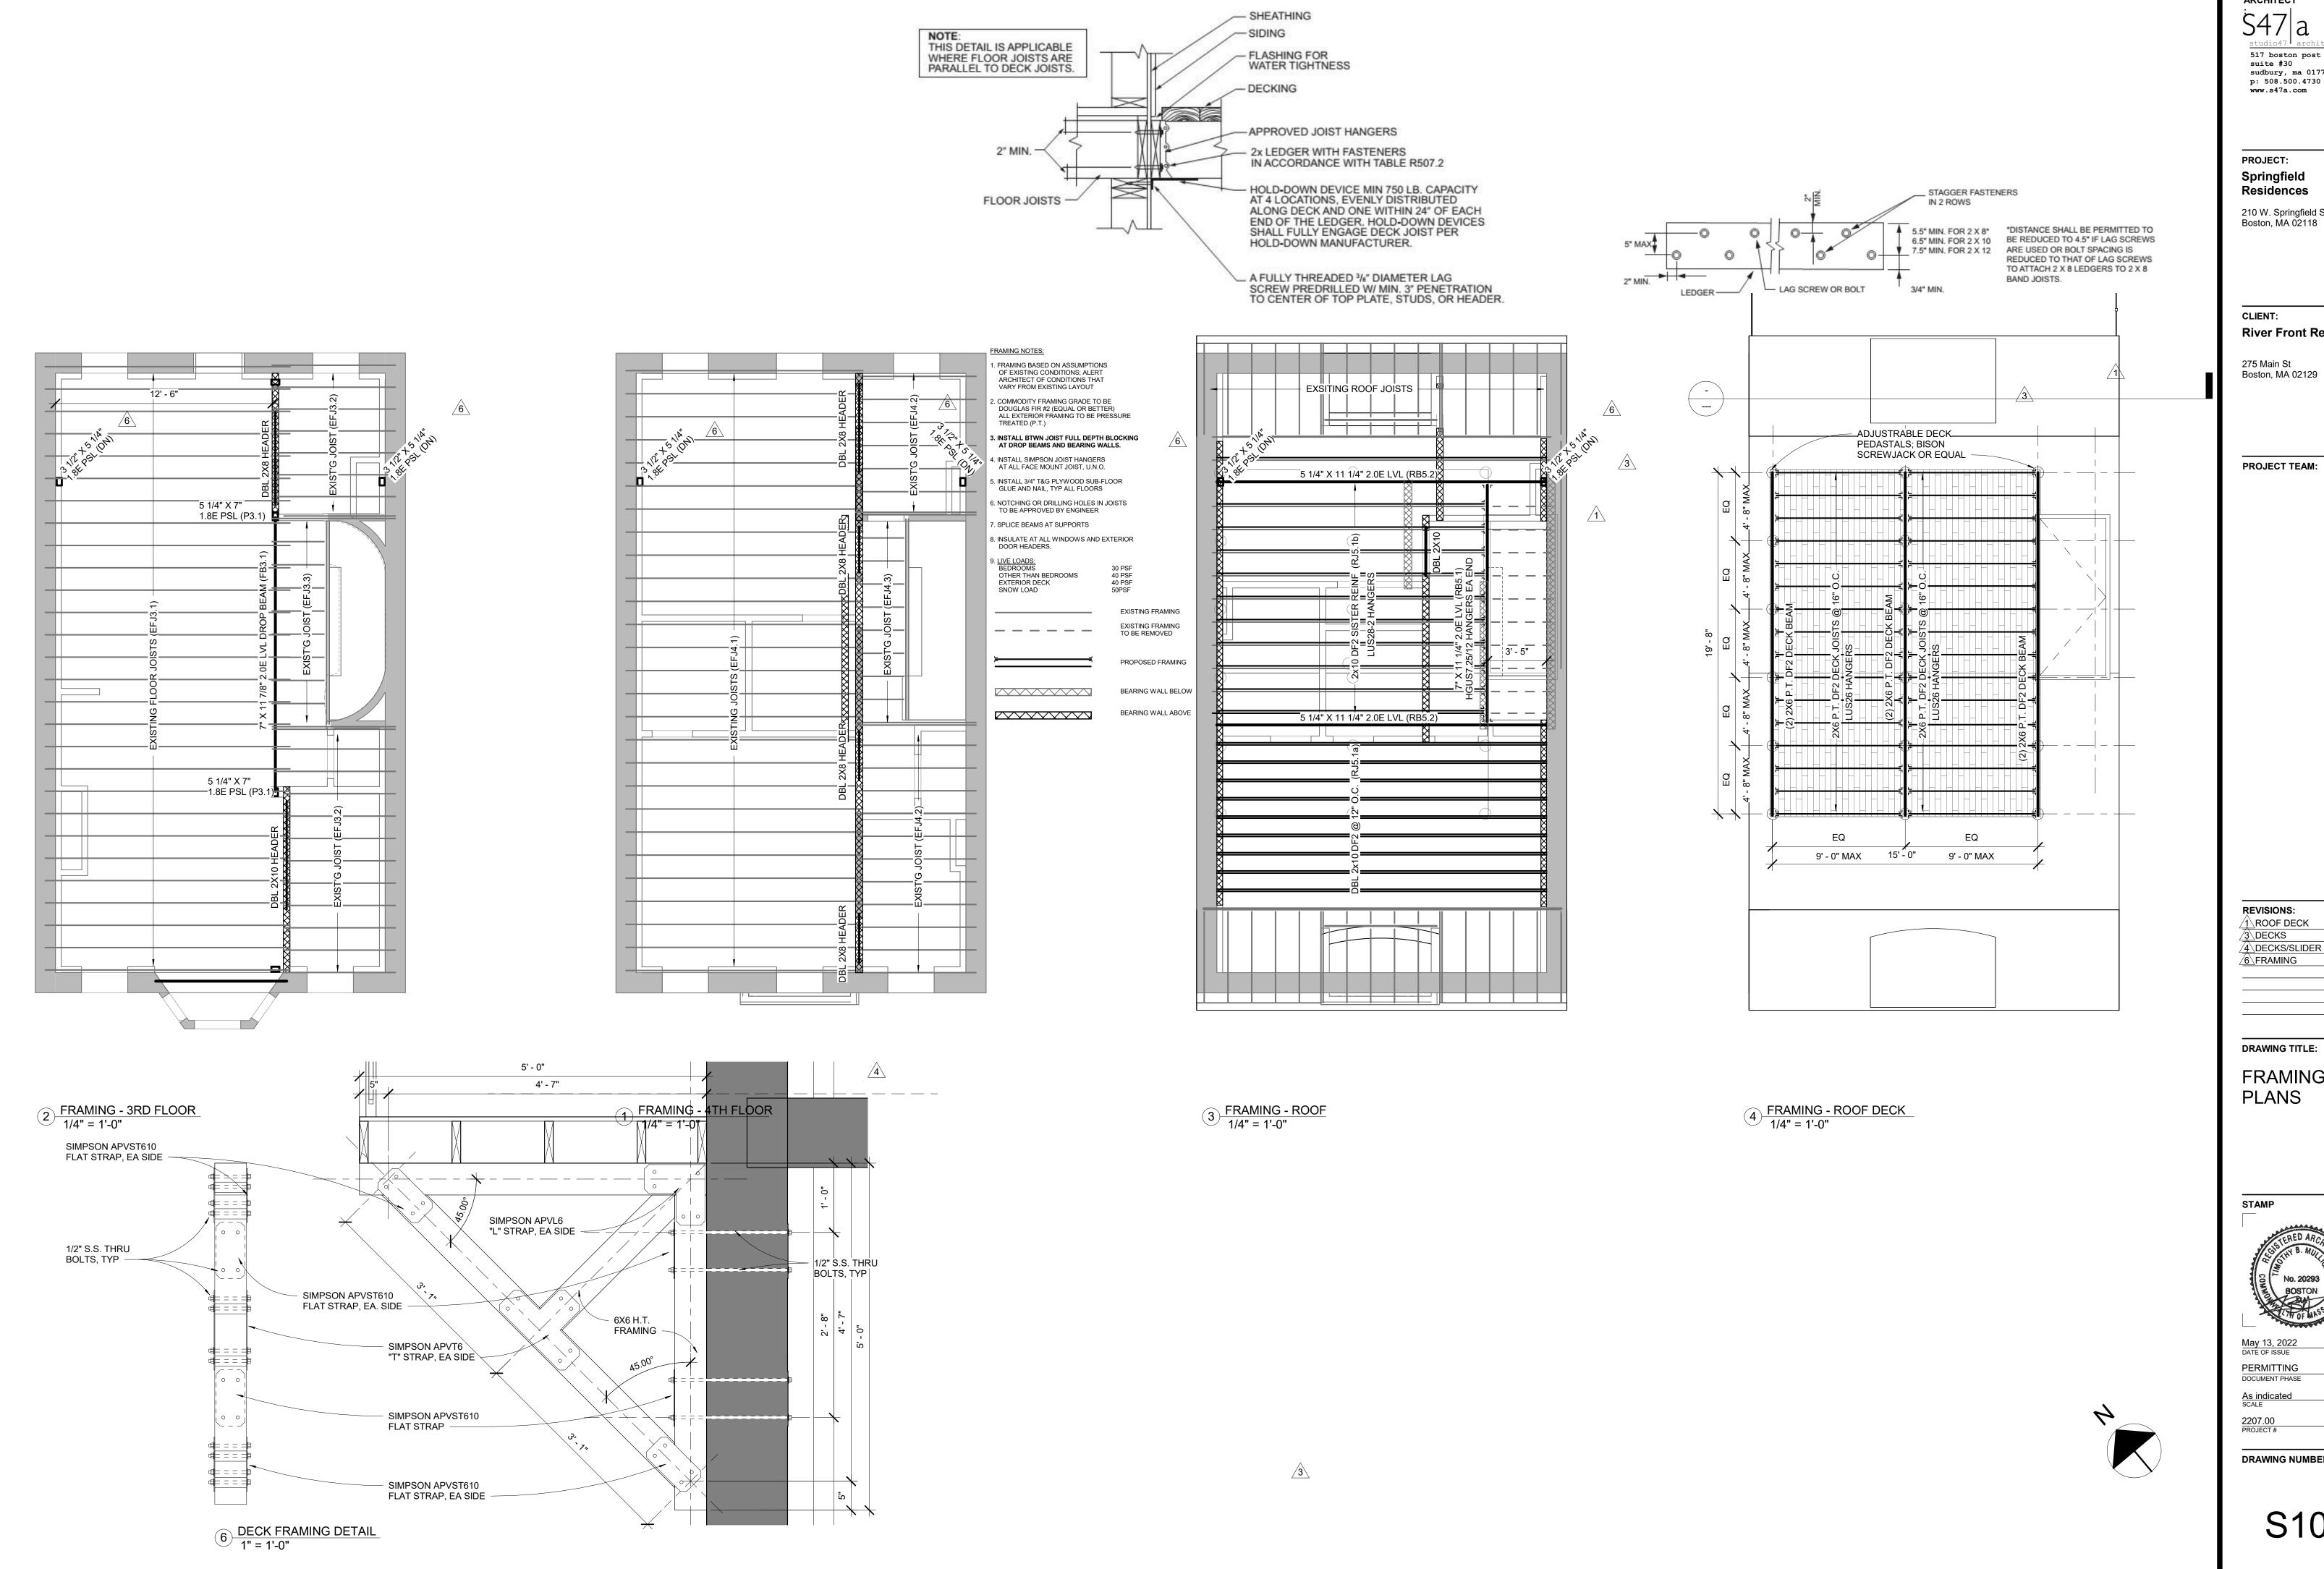
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www.s47a.com

PROJECT: Springfield Residences

210 W. Springfield St Boston, MA 02118

CLIENT:

River Front Realty


275 Main St

PROJECT TEAM:

REVISIONS: 1 ROOF DECK 6.22.22 3 DECKS 4 DECKS/SLIDER 1.11.23 6 FRAMING

DRAWING TITLE:

FRAMING **PLANS**

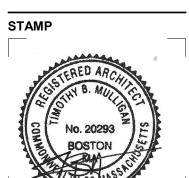

PERMITTING DOCUMENT PHASE

As indicated SCALE

DRAWING NUMBER:

S101